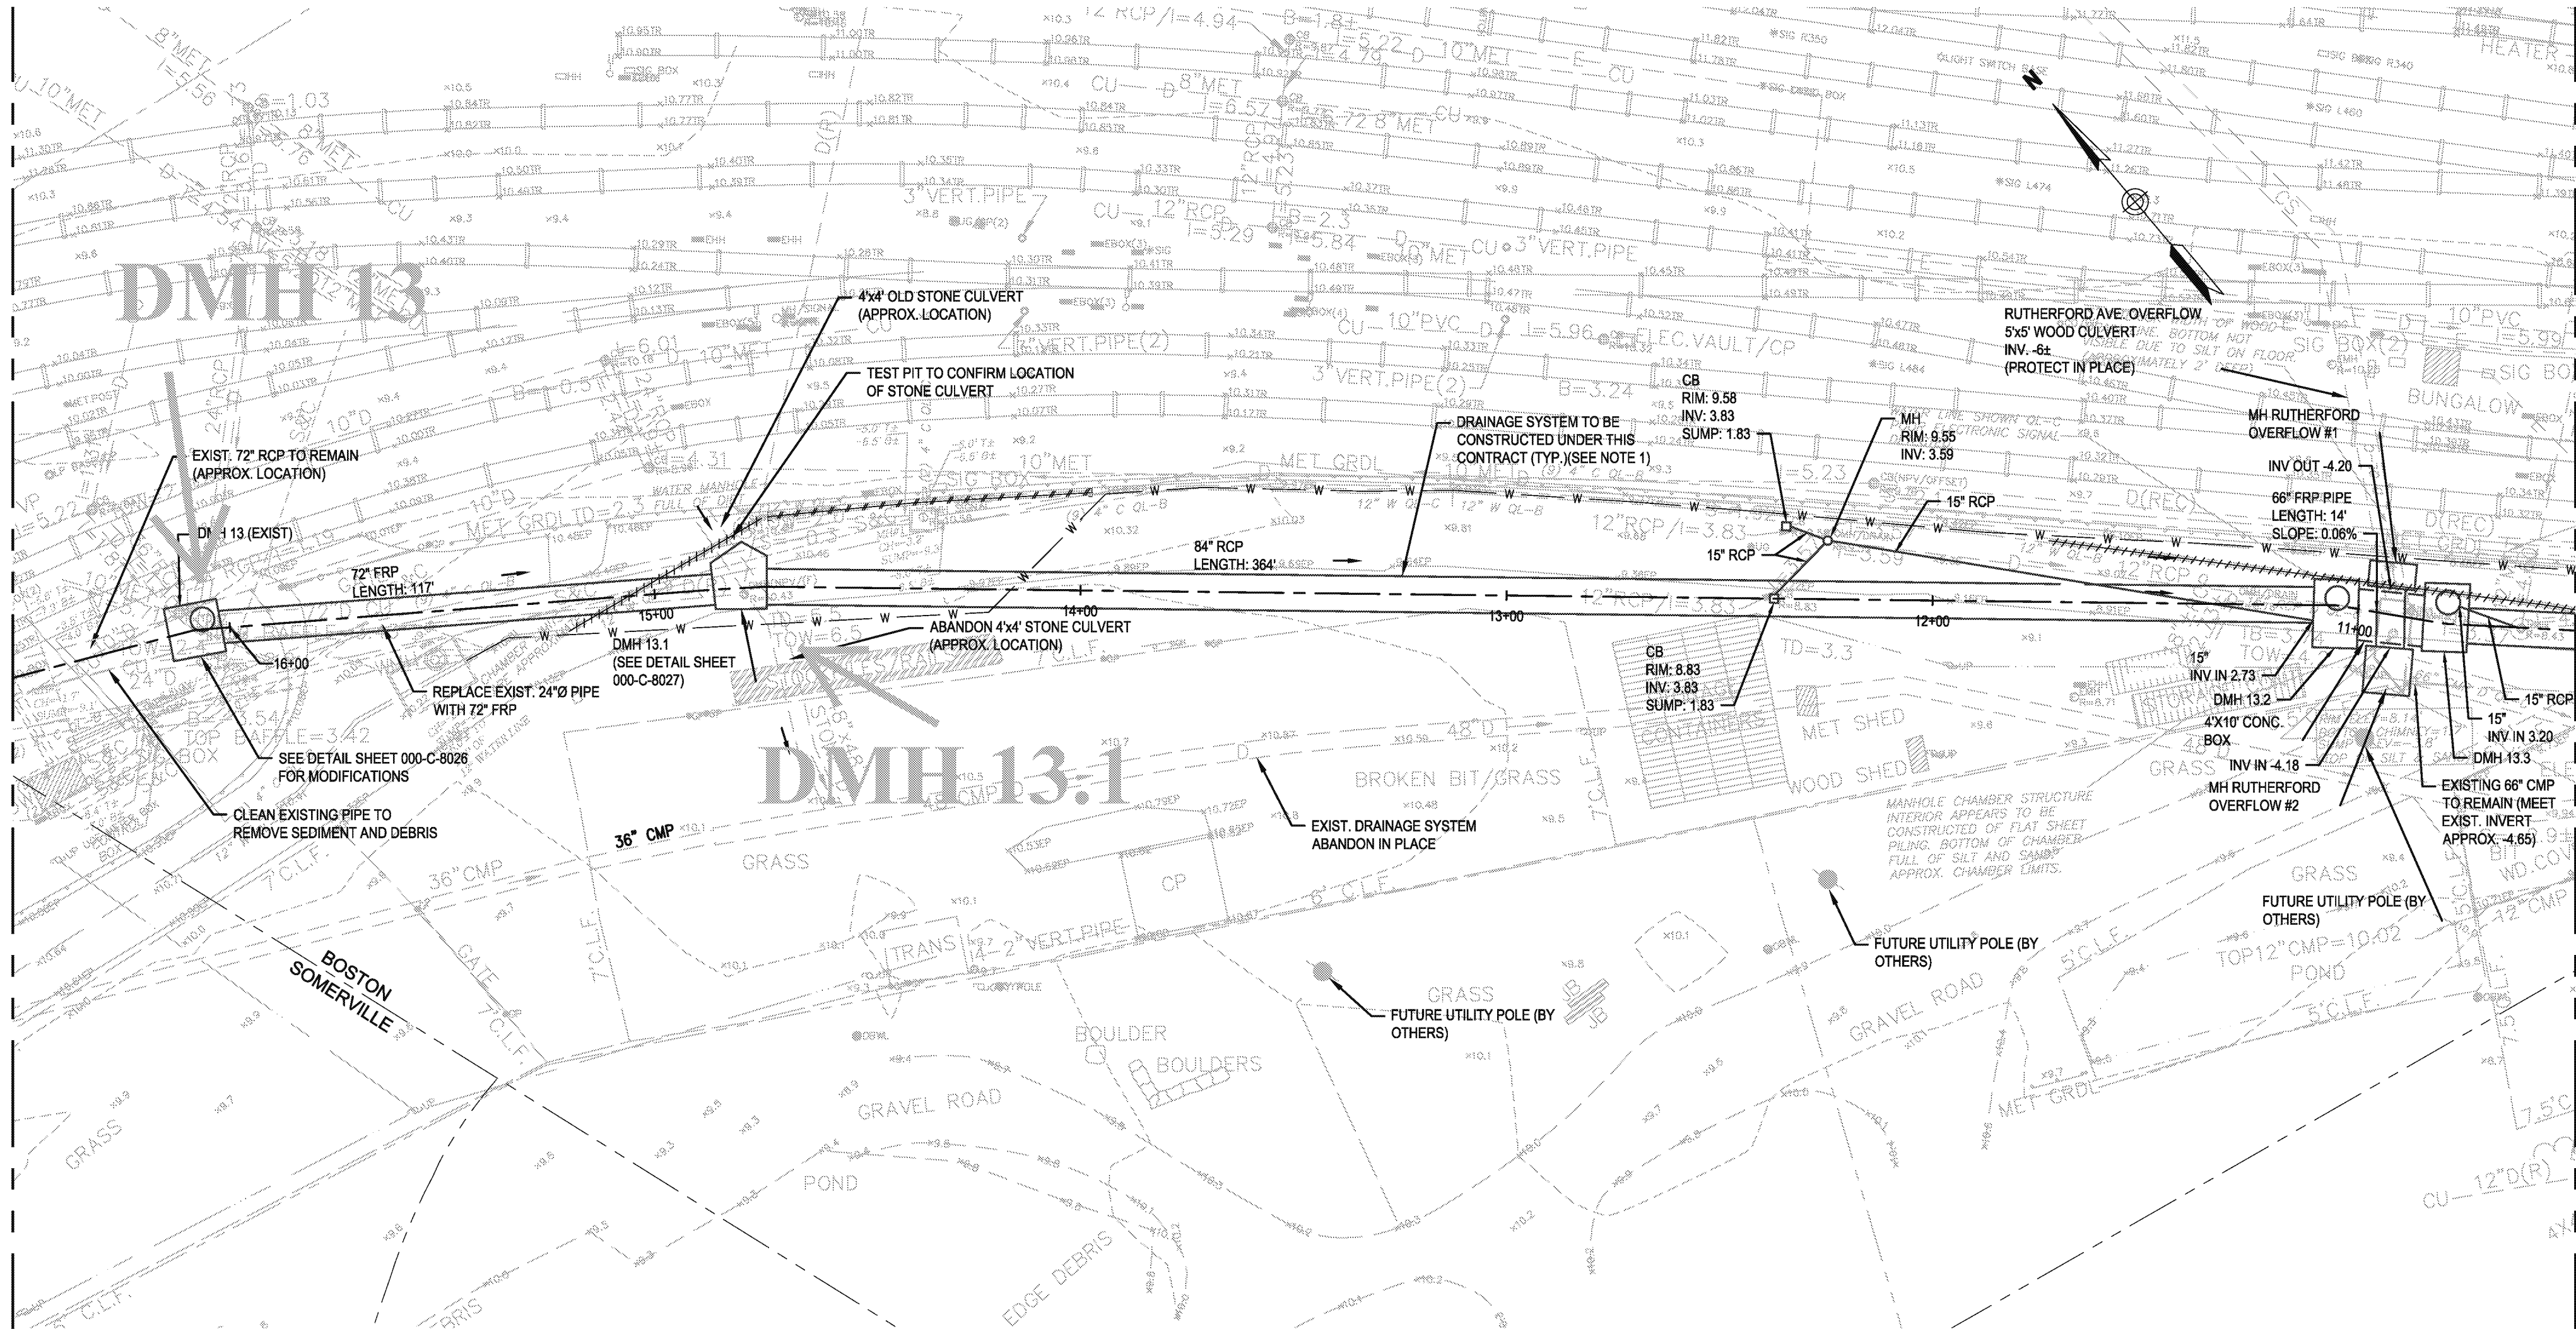


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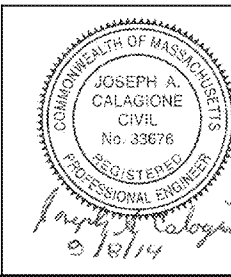
MATCHLINE SEE SHEET 000-C-2064



MATCHLINE SEE SHEET 000-C-2062

NOTES:

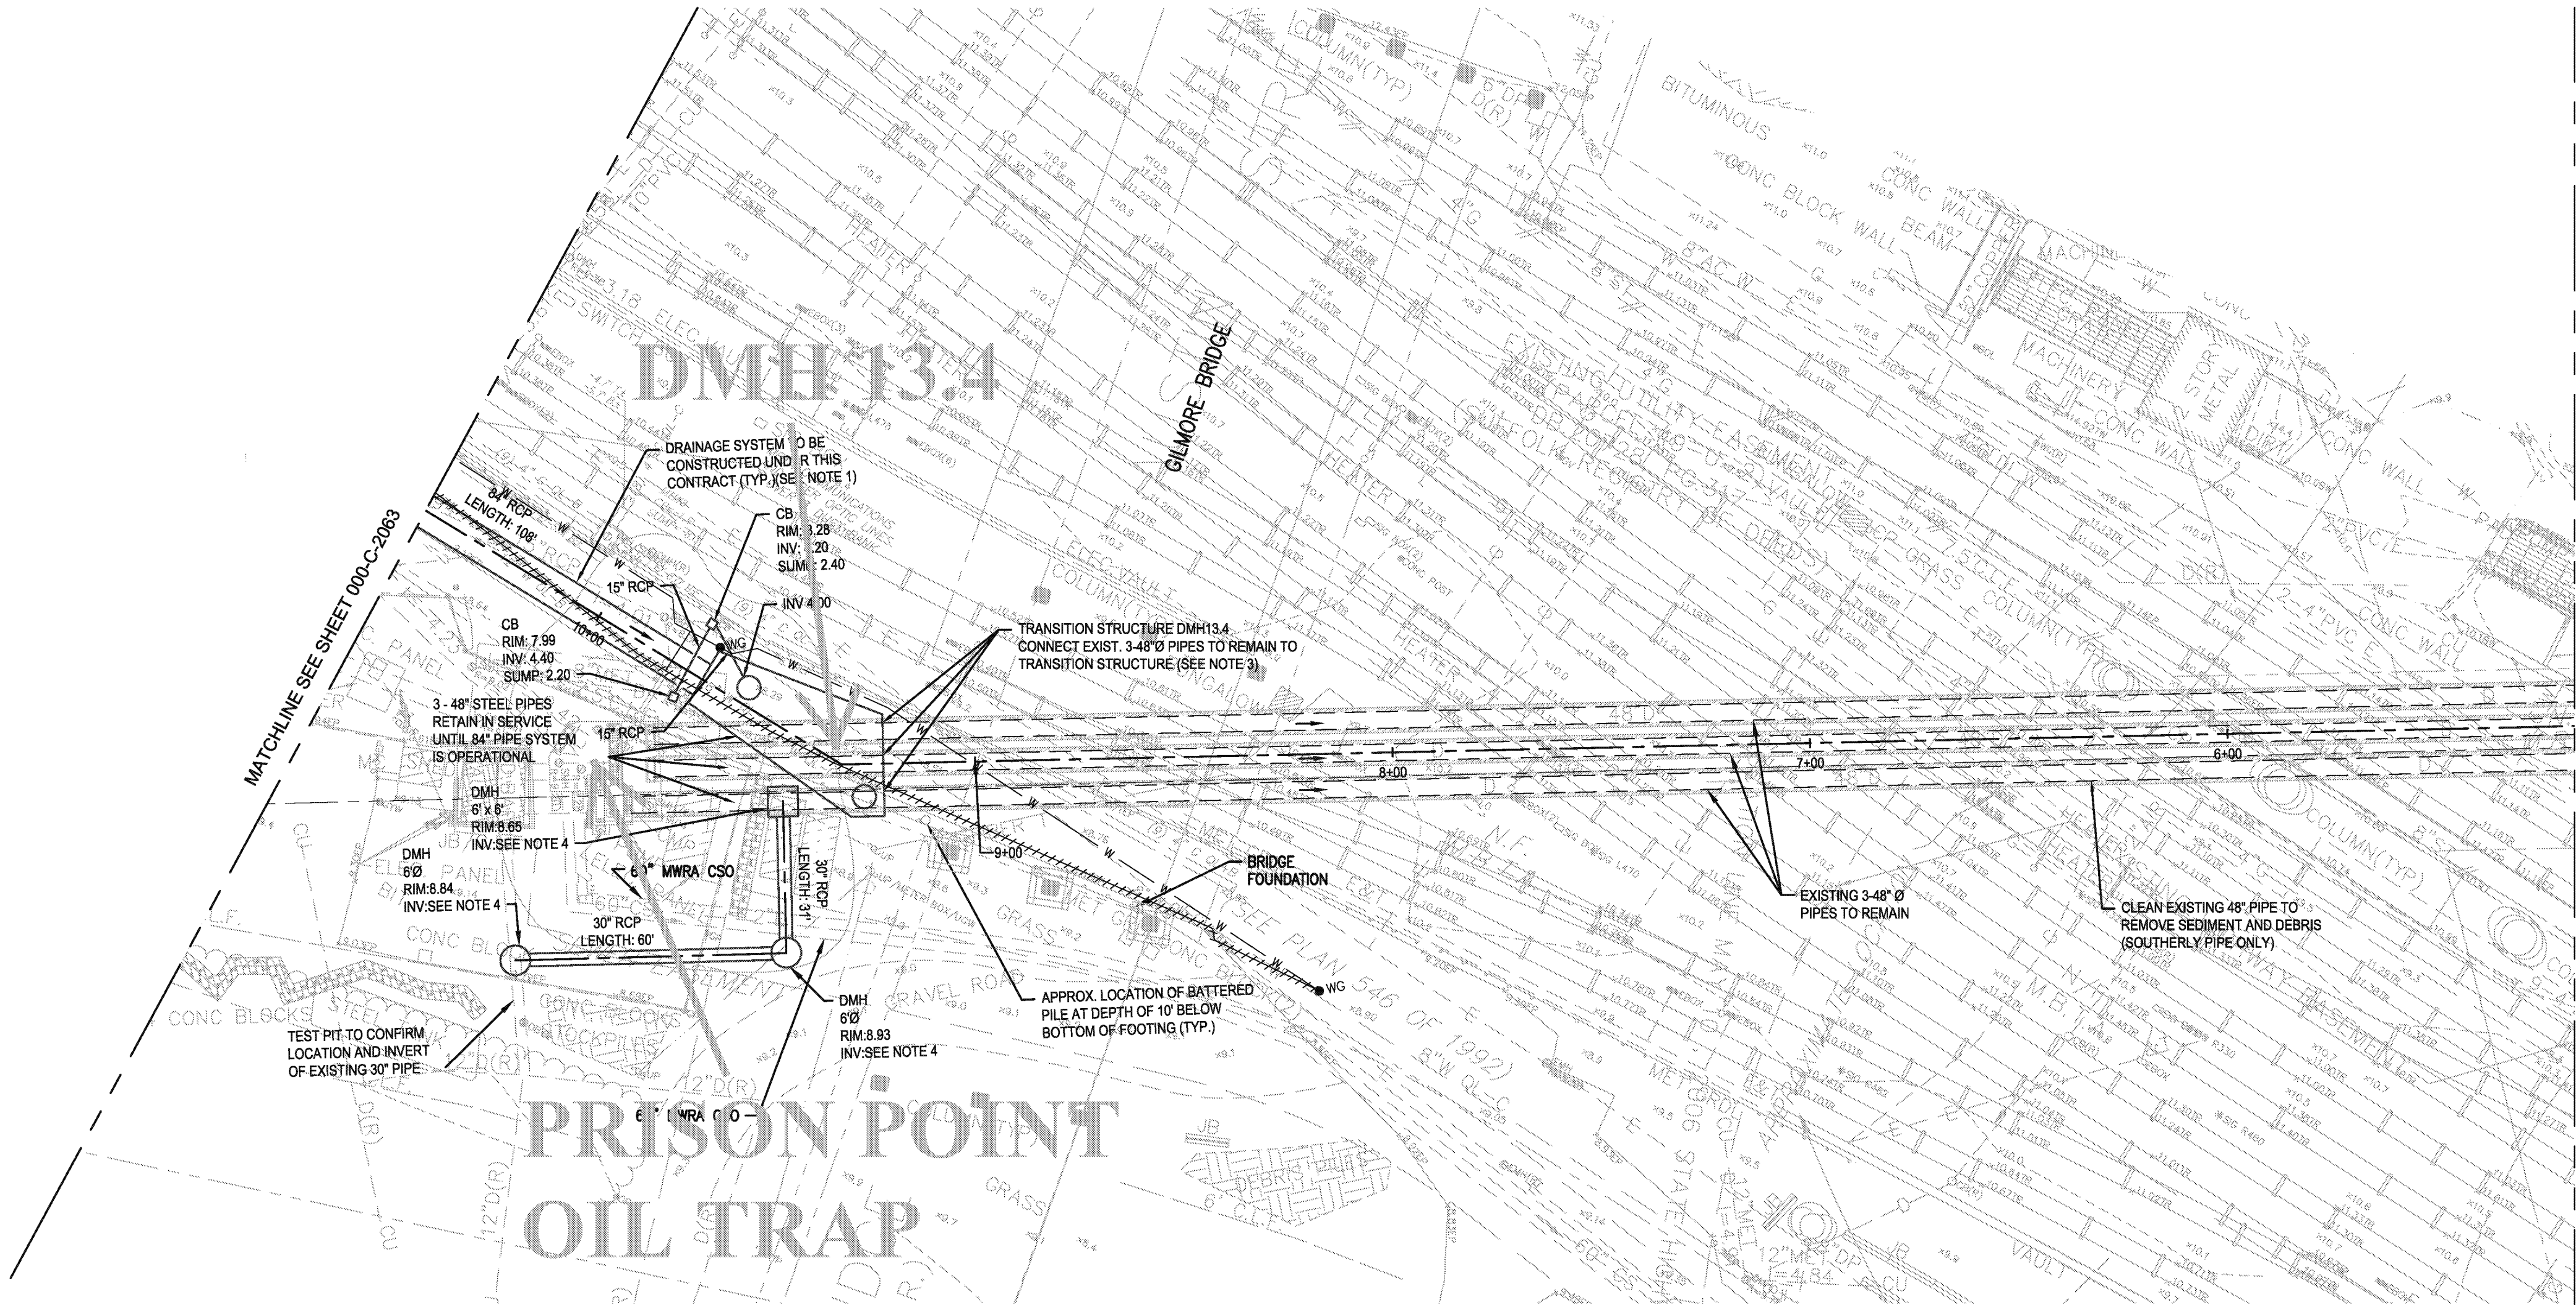
- WHEN PRINTING IN COLOR, THIS SHEET CONTAINS DRAINAGE SYSTEMS IN RED (PIPES AND MANHOLES) TO INDICATE DRAINAGE WORK CONSTRUCTED UNDER THIS CONTRACT (IGMP-03).
- SEE THE UTILITY PLANS FOR FURTHER DESCRIPTION OF PROPOSED UTILITIES AND IN WHICH SPECIFIC GLX CONTRACT EACH IS TO BE INSTALLED.
- FOR RUTHERFORD AVENUE OVERFLOW MANHOLE No. 1 AND No. 2 DETAILS, SEE SHEET 000-C-8026.
- SEE DETAILS SHEET 000-C-8027 FOR DMH 13.2 AND DMH 13.3.
- ALL EXISTING PIPES CONNECTED TO DMH 13 SHALL REMAIN IN SERVICE, EXCEPT THE 24\"/>
- CONTRACTOR SHALL COORDINATE AND WORK WITH THE COMMUTER RAIL OPERATOR REGARDING THE REMOVAL OF STOCKPILED MATERIALS WITHIN THE WORK ZONE FOR DMH-13 AND ADJACENT AREA DOWNSTREAM.
- FOR SPECIAL SUBGRADE PREPARATION AND BACKFILL REQUIREMENTS FOR ALL PIPES AND STRUCTURES ON THIS SHEET, SEE SHEET 000-C-0001.



GLX		massDOT	
		Massachusetts Department of Transportation	
0	09/12/14	CONFORMED DOCUMENT SUBMISSION - IGMP-03	
ISSUE	DATE	DESCRIPTION	BY
			CHKD
			APP

MASSACHUSETTS BAY TRANSPORTATION AUTHORITY	
GREEN LINE EXTENSION PROJECT MBTA CONTRACT NO. E22CN04 CAMBRIDGE/SOMERVILLE, MASSACHUSETTS	
MEDFORD BRANCH DRAINAGE PLAN MILLERS RIVER DRAINAGE SHEET 3	
AECOM HNTB	
SCALE: 1"=20'	DRAWN BY: SN
DATE: SEP 12, 2014	DESIGN BY: PWB
	CHECK BY: TMC
PLAN NO. 178,656	ISSUE 0
SHEET: 000-C-2063	

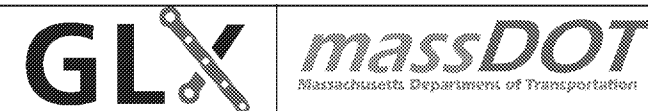
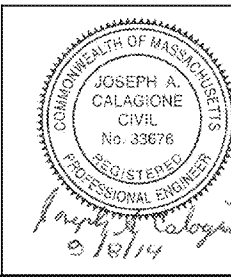
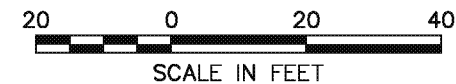
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NOTES:

1. WHEN PRINTING IN COLOR, THIS SHEET CONTAINS DRAINAGE SYSTEMS IN RED (PIPES AND MANHOLES) TO INDICATE DRAINAGE WORK CONSTRUCTED UNDER THIS CONTRACT (IGMP-03).
2. SEE THE UTILITY PLANS FOR FURTHER DESCRIPTION OF PROPOSED UTILITIES AND IN WHICH SPECIFIC GLX CONTRACT EACH IS TO BE INSTALLED.
3. FOR DETAILS OF DMH 13.4 SEE DETAILS ON SHEET 000-C-8028.
4. PROFILE SHALL BE ESTABLISHED BY ENGINEER BASED ON INVERTS ESTABLISHED IN THE FIELD BY CONTRACTOR.

5. FOR SPECIAL SUBGRADE PREPARATION AND BACKFILL REQUIREMENTS FOR ALL PIPES AND STRUCTURES ON THIS SHEET, SEE SHEET 000-C-0001.



ISSUE	DATE	DESCRIPTION	BY	CHKD	APP
0	09/12/14	CONFORMED DOCUMENT SUBMISSION - IGMP-03			

MASSACHUSETTS BAY TRANSPORTATION AUTHORITY	
GREEN LINE EXTENSION PROJECT MBTA CONTRACT NO. E22CN04 CAMBRIDGE/SOMERVILLE, MASSACHUSETTS	
MEDFORD BRANCH DRAINAGE PLAN MILLERS RIVER DRAINAGE SHEET 2	
SCALE: 1"=20'	DRAWN BY: SN
DATE: SEP 12, 2014	DESIGN BY: PWB
	CHECK BY: TMC
PLAN NO. 178,655	ISSUE 0
SHEET: 000-C-2062	

OLD STONE CULVERT CLEANING



